

# ELKHART COUNTY COURTHOUSE - WEST EXTERIOR STAIR RECONSTRUCTION

GOSHEN, INDIANA

# BID DOCUMENTS JUNE 2, 2022

### ELKHART COUNTY

**BOARD OF COMISSIONERS** 

FRANK LUCCHESE - VICE PRESIDENT DISTRICT 1
BRAD ROGERS - MEMBER DISTRICT 2
SUZANNE WEIRICK - PRESIDENT DISTRICT 3

#### **ADMINISTRATION**

JEFFERY TAYLOR, COUNTY ADMINISTRATOR
DONALD TUBICISAK, DIRECTOR OF BUILDINGS AND GROUNDS

#### **FACILITY ADDRESS**

ELKHART COUNTY COURTHOUSE 101 N. MAIN ST. GOSHEN, INDIANA 46526



DLZ PROJECT NO. 2261-4862-01



ARCHITECT/ENGINEER:

DLZ INDIANA, LLC


2211 E. Jefferson Blvd.


South Bend, Indiana 46615

Office: 574.236.4400

Fax: 574.236.4471



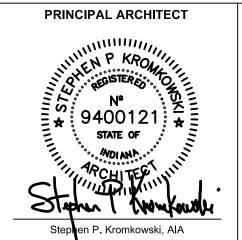

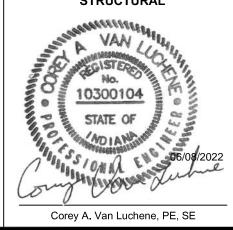

# ABBREVIATIONS

# SYMBOLS

# SHEET INDEX

#### **ABBREVIATIONS**

CTW

CTR.

CU.

CW

DBL.

DEG.

DEMO

DEPT.

DIA.

DWG.

E.I.F.S.

EMER.

E.PAN.

E.W.

E.W.C.

ELEC.

ELEV.

ENG.

EQ.

E.S.

EQUIP

ETC.

EXP.

EXT.

EXIST.

F.A.C.P.

F.A.I.

F.E.C.

F.W.C

FLR.

FTG.

DTL.

CERAMIC TILE FLOOR

CERAMIC TILE WALL

DRINKING FOUNTAIN

CUBIC

**COLD WATER** 

DEAD LOAD

DOUBLE

DEGREE

DOWN SPOUT

DEMOLISH (ED)

DEPARTMENT

DIAMETER

**DIMENSION** 

DOOR

DETAIL

DRAWING

EXHAUST AIR

**EMERGENCY** 

**EACH WAY** 

**ELEVATION** 

**ELEVATOR** 

**EQUIPMENT** 

**ET CETERA** 

**EXPANSION** 

EXTERIOR

FURNACE

FLOOR DRAIN

FRESH AIR INTAKE

FIRE EXTINGUISHER

FIRE HOSE CABINET

FABRIC WALL COVERING

FLOOR MOUNTED

FIN RADIATION

**FOOD SERVICE** 

FIELD VERIFY

FOOT OR FEET

FINISH

FLOOR

FOOTING

EXISTING

EQUAL

EXHAUST FAN

EXPANSION JOINT

**ELECTRICAL PANEL** 

ELECTRICAL CONTRACTOR

ELECTRIC WATER COOLER

ELECTRICAL OR ELECTRIC

**EXPOSED STRUCTURE** 

ENGINEER OR ENGINEERING

FIRE ALARM CONTROL PANEL

FIRE EXTINGUISHER CABINET

EXT. INSULATION FINISH SYSTEM

G.A. ANCHOR BOLT G.C. AIR CONDITIONING GENERAL CONTRACTOR A.C.T ACOUSTICAL CEILING TILE G.R.V. **GRAVITY ROOF VENTILATOR** A.D. AREA DRAIN GL. GLASS GND. ADD. ADDENDUM GROUND A.F.F. ABOVE FINISHED FLOOR GRADE A.F.G. **ABOVE GRADE** GYP.BD. **GYPSUM BOARD** A.P. **ACCESS PANEL** ACOUSTICAL PLASTER CEILING A.P.C. H.B. HOSE BIBB A.V. AUDIO VISUAL ADMIN. **ADMINISTRATION** H.M. **HOLLOW METAL** AGGR. HAND-OFF-AUTOMATIC AGGREGATE HEATING VENTILATING & AIR-CONDITIONING R.H. ALT. ALTERNATE H.V.A.C ALUM. ALUMINUM **HOT WATER APPROX APPROXIMATE** HWS HOT WATER SUPPLY ARCH. HWR ARCHITECT (ARCHITECTURAL) HOT WATER RETURN HDWD. ASPH. **ASPHALT** HARDWOOD ASSOC. **ASSOCIATE** HDWR. HARDWARE AVG. **AVERAGE** HT (HGT. HEIGHT HIGH DENSITY PARTICLE BOARD BOTTOM HORIZ. B.(BOTT.) HORIZONTAL BOND BEAM HR. B.C. **BOTTOM OF CURB** HYD. **HYDRAULIC** BARRIER FREE B.F.P **BACK FLOW PREVENTER** INSIDE DIAMETEI BUILDING LINE INSIDE FACE B.M. **BENCH MARK** I.R. INSIDE RADIUS B.T.U **BRITISH THERMAL UNIT BUILT UP** INFORMATION INSUL BOARD INSULATION BTWN **BETWEEN** INT. INTERIOR BLDG. INVERT BUILDING BLK. BLOCK BLKG. BLOCKING JANITOR OR JANITORIAL J.B. JUNCTION BOX BEAM JCT BULLET RESISTANT JUNCTION BRG. BEARING JOINT BRZ. BRONZE BSMT **BASEMENT** K.D. KILN-DRIED KITCHEN CONDUIT K.O. KNOCKOUT CAB. CABINET KICK PLATE C.B. **CATCH BASIN** CB. **CORNER BAR** LEFT **CENTER TO CENTER** LAMINATED CEM. CEMENT LAV. LAVATORY CER. **CERAMIC** LBS. POUNDS C.F.M. **CUBIC FEET PER MINUT** LG. LARGE LGTH CORNER GUARD LENGTH C.I. CAST IRON LEFT HAND L.H. C.I.P. **CAST IRON PIPE** LFT.(LF.) LINEAR FEET CIR. CIRCLE OR CIRCULAR LEFT HAND REVERSE CONTROL JOINT LIVE LOAD CKBD. L.O.A. LENGTH OVER ALL CHALKBOARD CL CENTERLINE LIN. LINEAR C.L. **CONSTRUCTION LINE** LTG. LIGHTING CLG. CEILING CLOS. CLOSET M.C. MECHANICAL CONTRACTOR CLR. CLEAR M.D.P. MAIN DISTRIBUTION PANEL C.M.U. **CONCRETE MASONRY UNIT** MAN HOLE M.O. C.O. **CLEAN OUT** MASONRY OPENING COL. MATL COLUMN MATERIA COMP COMPACTED MAX. **MAXIMUM** CONC. CONCRETE MECH. MECHANICA COND. CONDENSATE MEMB. MEMBRANE CONST MEZZ. CONSTRUCTION MEZZANINE CONTINUOUS CONTR. CONTRACTOR MINIMUM COORD. COORDINATE MISCELLANEOUS CORR. CORRIDOR MIX. MIXTURE CORG CORRUGATED MARK CPT. M.O. MASONRY CARPETING CSJ CONSTRUCTION JOINT MTD. MOUNTED C.S. MTL. CAULKING SEAM METAL CTB CENTER OR CENTERING MTG. MOUNTING CERAMIC TILE BASE

O.R.

OL.

OFC.

OPNG.

ORIG.

OZ.

P.A.

P.C.

P.D.

P.J.F.

P.R.V.

PASS.

PAT.

PERP.

P.LAM.

PLAS.

PLBG.

PNEU.

PROJ.

PLYWD.

PREFAB.

P.CONC.

PTN.

PVC.

QCV

QUAL.

QTY.

Q.T.

OUTSIDE RADIUS

OUTSIDE RADIUS

PIPE ANCHOR

PASSENGER

PATTERN

PLASTIC

PLUMBING

PLYWOOD

PROJECT

PARTITION

QUARRY TILE

QUALITY

QUANTITY

PAVERS

PANEL

PNEUMATIC

PREFABRICATED

PRECAST CONCRETE SLAB

POLYVINYL CHLORIDE

QUICK COUPLER VALVE

PRESSURE DROP

PERPENDICULAR

PLASTIC LAMINATE

PLUMBING CONTRACTOR

PRE MOLDED JOINT FILLER

PRESSURE REDUCING VALVE

OVERLOAD

OVERHEAD

OPENING

OPPOSITE

ORIGINAL

OUNCE

OFFICE

REINF REQD REV. RFG. R.R. RWC. RWL S.A. S.A.T. S.C. S.F.S. S.P.S. S.S. S. TO S SHM. S.V. SAN. SECT. SEW. SHT. SHWR S.O. SPECS. STD. STOR. STRUCT SUSP. SW. T.&B. T.&G. T.C.C. T.C.P. T.W.C. **TEMP** TERR. THRU. TKBD. TLT. NORTH TYP. NA(N/A) NOT APPLICABLE N.I.C. NOT IN CONTRACT NF U.F.D. NEAR FACE N.O.P. NOT OTHERWISE PROVIDED NO. UNO NUMBER NOM. NOMINAL U.V. N.T.S. NOT TO SCALE UTIL. OVERALL O.A. OUTSIDE AIR O.A.I. OUTSIDE AIR INTAKE O.C. ON CENTER VAR. O.D. OUTSIDE DIAMETER VCB O. TO O. OUT TO OUT V.C.P. OUTSIDE FACE VCT

THERMAL RESISTANCE RISER OR RIGHT RADIUS RETURN AIR RUBBER BASE RUBBER ROAD **ROOF DRAIN** RECESSED REFERENCE REVISION REMOVABLE RIGHT HAND RIGHT HAND REVERSE REINFORCED CONCRETE PIPE REFER TO: RECEPTACLE RECTANGLE OR RECTANGULAR REFRIGERATOR REINFORCE (D) (ING) (MENT) REQUIRED REVERSE ROOFING RAILING ROOM RAIL ROAD RIGHT RIGHT OF WAY REVERSE MAIN WATER COLLECTOR RAIN WATER LEADER

RAD (R.)

REM.

RCP

RECPT

RECT.

REFR.

SUSPENDED ACOUSTICAL TILE SEALED CONCRETE STORE FRONT SYSTEM STAND PIPE SOUTH STAINLESS STEEL STUD TO STUD SECURITY HOLLOW METAL SHEET VINYL SANITARY **SCHEDULE** SECTION SEWER SHEET SHOWER SIMILAR SECTIONAL OVERHEAD **SPECIFICATIONS** SPEAKER SQUARE STEEL STANDARD **STORAGE** STRUCTURA SUSPENDED SWITCH

TEMPERED TOP AND BOTTOM TONGUE AND GROOVE TOP CURB TEMP. CONTROL CONTRACTOR TEMP. CONTROL PANEL TEPID WATER TEPID WATER CONTROLLER TILE BACKER BOARD TELEPHONE **TEMPERATURE** TERRAZZO THROUGH TACK BOARD TOILET **TOLERANCE** TYPICAL

HEAT TRANSFER COEFFICIENT UNDER FLOOR DUCT **UNDERWRITER'S LABORATORIES** UNLESS NOTED OTHERWISE UNIT VENTILATOR URINAL UTILITY

VINYL VAPOR VARIES VINYL COVE BASE VITRIFIED CLAY PIPE VINYL COMPOSITION TILE VERTICAL **VESTIBULE** VENTILATE VERIFY IN FIELD VOLUME VENT PIPE VENT STACK VINYL WALL COVERING

VERT.

VEST.

VENT.

VOL.

V.P.

V.S.

VWC

W.C.

W.F.

WH

W.H.

W.P.

WS

W.S.

W.W.F.

XFMR

XFR

YCO

WATER CLOSET WOOD WASH FOUNTAIN WALL HUNG WATER HEATER WROUGHT IRON WORKING POINT WATERPROOFING WIND LOAD WALK OFF MAT WEATHER STRIP WORK SINK WELDED WIRE FABRIC WEIGHT

TRANSFORMER TRANSFER YARD CLEAN OUT

DEGREE PLUS OR MINUS DIAMETER **CENTERLINE** PLATE AND NUMBER

WITH

# ✓3 ← ELEVATION NUMBER

DRAWING TITLE —DETAIL NUMBER XXX — DRAWING NAME SCALE: **→** DRAWING SCALE

ROOM NAME AND NUMBER NAME #

DOOR MARK TARGET KEYNOTE TARGET

> |XXXX| (X)WALL TYPE TARGET

WINDOW TARGET

# EXTERIOR ELEVATION TARGET

A5.1 <del>▼</del> SHEET NUMBER INTERIOR ELEVATION TARGET

NUMBER SHT<del>→</del>SHEET NUMBER BUILDING SECTION TARGET


SHT SHEET NUMBER SHI WALL SECTION TARGET

VIEW NUMBER -

SHEET NUMBER -SH SECTION DETAIL TARGET

SHEET NUMBER —

VERTICAL ELEVATION BUBBLE

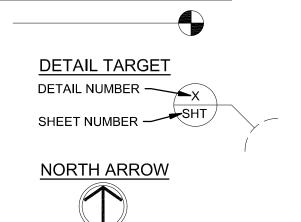


PHOTOGRAPH TARGET -SHEET NUMBER -DIRECTION OF

GENERAL TITLE SHEET G1.0 G1.1 GENERAL NOTES AND INFORMATION

STRUCTURAL S1.0 STRUCTURAL PLANS AND DETAILS **PHOTOGRAPHS** 

# LOCATION MAP

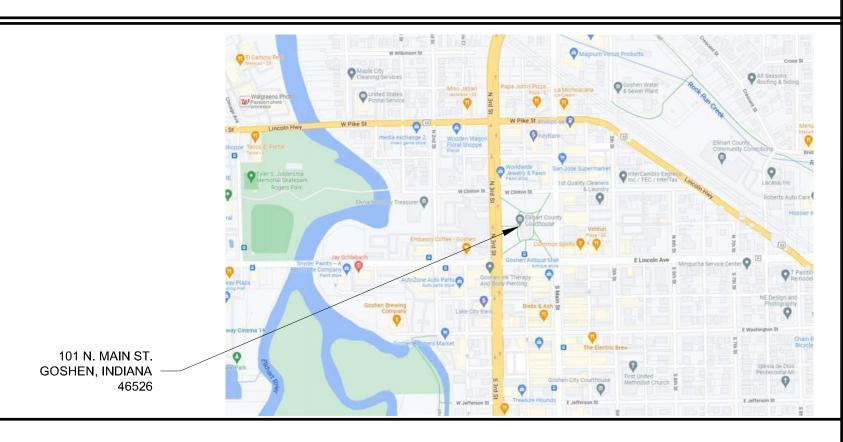

# GENERAL NOTES

#### GENERAL

- A. CONTRACTOR IS RESPONSIBLE TO CONFORM WITH APPLICABLE FEDERAL, STATE, AND LOCAL CODES AND REGULATIONS INCLUDING
- CONTRACTOR IS RESPONSIBLE TO FIELD VERIFY ALL DIMENSIONS AND EXISTING CONDITIONS PRIOR TO SUBMITTING A BID OR BEGINNING ANY WORK. CONDITIONS FOUND TO BE IN VARIANCE FROM THE INFORMATION IN THE DRAWINGS OR PROJECT MANUAL SHALL BE SUBMITTED TO THE ARCHITECT IN WRITING FOR CLARIFICATION.
- CONTRACTOR IS RESPONSIBLE FOR ALL WORK IDENTIFIED ON ALL DRAWINGS AND INFORMATION IN THE PROJECT MANUAL. AS A COMPLETE
- CONDUIT, AND OTHER UTILITIES PRIOR TO PERFORMING ANY EARTHWORK, EXCAVATION, OR UTILITY WORK. ENGAGE THE SERVICES OF A
- LOCATION OF ALL TEMPORARY FACILITIES SHALL BE COORDINATED WITH OWNER AND ARCHITECT PRIOR TO MOBILIZATION ON-SITE, INCLUDING BUT NOT LIMITED TO TEMPORARY STAGING AREA, MATERIAL STORAGE AREA, ACCESS DRIVE(S), PARKING AREA, TOPSOIL STOCKPILE AREA, WASTE DISPOSAL AREA, FIELD OFFICES AND TEMPORARY FACILITIES, JOB SIGN, AND TEMPORARY FENCING. CONTRACTOR IS RESPONSIBLE TO PROVIDE ALL MISCELLANEOUS BLOCKING REQUIRED FOR INSTALLATION OF ALL BUILDING COMPONENTS,
- INCLUDING BUT NOT LIMITED TO FURNISHINGS, FIXTURES, EQUIPMENT, HARDWARE, BRACKETS, AND OWNER-PROVIDED EQUIPMENT. CONTRACTOR SHALL COORDINATE SPECIFIC REQUIREMENTS ASSOCIATED WITH EACH TRADE AND WITH OWNER'S REPRESENTATIVE G. CONTRACTOR IS RESPONSIBLE TO PROVIDE ALL MISCELLANEOUS WOOD AND METAL TRIM, FLASHING, CLIP ANGLES, ANCHORS, SUPPORTS, AND
- CLOSURE TRIM REQUIRED TO PROVIDE A COMPLETE, UNIFORM, AND WEATHERTIGHT ASSEMBLY AS REQUIRED TO ACCOMPLISH THE DESIGN H. ALL EQUIPMENT SHALL BE INSTALLED IN ACCORDANCE WITH MANUFACTURER'S WRITTEN RECOMMENDATIONS. CONTRACTOR SHALL PROVIDE AND INSTALL ALL ACCESSORY COMPONENTS AS REQUIRED TO FULLY COMPLY WITH MANUFACTURER'S RECOMMENDATIONS.

CONTRACTOR SHALL PROVIDE ACCESS DOORS IN ALL WALLS AND CEILINGS WHERE SERVICE OR ADJUSTMENT TO MECHANICAL, PLUMBING,

- FIRE PROTECTION OR ELECTRICAL ITEMS MAY BE REQUIRED. ACCESS DOORS SHALL BE OF AN APPROPRIATE SIZE REQUIRED FOR EACH APPLICATION. WHERE APPLICABLE, ACCESS DOORS SHALL MATCH THE FIRE RATING OF THE WALL ASSEMBLY. CONTRACTOR SHALL SEAL ALL PENETRATIONS IN EXTERIOR WALL AND ROOF ASSEMBLIES WITH APPROPRIATE JOINT SEALANT(S) AND
- FLASHING(S) TO MAINTAIN A WEATHERTIGHT AND AIRTIGHT BUILDING ENVELOPE. ALL JOINTS AND PENETRATIONS SHALL BE SEALED, GASKETED, OR WEATHER-STRIPPED TO MINIMIZE AIR LEAKAGE, INCLUDING THE FOLLOWING:
- 1) JOINTS AROUND FENESTRATION AND DOOR FRAMES.
- 2) JUNCTIONS BETWEEN WALLS AND FOUNDATIONS, BETWEEN WALLS AT BUILDING CORNERS, BETWEEN WALLS AND FLOORS OR ROOFS, AND BETWEEN WALLS AND ROOF OR WALL PANELS.
- 3) OPENINGS AT PENETRATIONS OF UTILITY SERVICES THROUGH ROOFS, WALLS, AND FLOORS.
- 4) JOINTS, SEAMS, AND PENETRATIONS OF VAPOR RETARDERS. 5) ALL OTHER OPENINGS IN THE BUILDING ENVELOPE.
- K. COORDINATE WITH OTHER CONSTRUCTION ACTIVITIES AND CONSTRUCTION SEQUENCING WITH OTHER PROJECT(S) AND WORK BEING
- PERFORMED CONCURRENTLY ON-SITE. CONTRACTOR TO PROTECT ALL ITEMS WITHIN THE CONSTRUCTION LIMITS (INCLUDING SITE ELEMENTS) THAT ARE DESIGNATED TO REMAIN; ITEMS DAMAGED AS A RESULT OF WORK PERFORMED UNDER THIS CONTRACT SHALL BE REPAIRED OR REPLACED TO ORIGINAL CONDITION.
- M. INFORMATION ON THIS SHEET SUPPLEMENTS THE PROJECT SPECIFICATIONS. REFER TO PROJECT SPECIFICATIONS FOR ADDITIONAL
- N. UNLESS OTHERWISE NOTED, ALL DETAILS, SECTIONS AND NOTES ON THE DRAWINGS ARE INTENDED TO INDICATE DESIGN INTENT AND ARE TO BE TYPICAL FOR SIMILAR SITUATIONS ELSEWHERE. O. CONTRACTOR IS TO ASSUME FULL RESPONSIBILITY, UNRELIEVED BY REVIEW OF SHOP DRAWINGS OR PERIODIC OBSERVATION OF
- CONSTRUCTION, FOR COMPLIANCE WITH THE CONTRACT DOCUMENTS, FOR DIMENSIONS TO BE CONFIRMED AND CORRELATED ON THE JOB SITE AND BETWEEN INDIVIDUAL DRAWINGS OR SETS OF DRAWINGS FOR FABRICATION PROCESSES AND CONSTRUCTION TECHNIQUES (INCLUDING EXCAVATION, SHORING, SCAFFOLDING, BRACING, ERECTION, FORMWORK, ETC.), FOR COORDINATION OF THE VARIOUS TRADES, AND FOR SAFE CONDITIONS ON THE JOB SITE. VARIATIONS IN FIELD CONDITIONS RELATIVE TO THE CONTRACT DOCUMENTS SHALL BE REPORTED TO THE ENGINEER AS SOON AS THEY ARE FOUND. WORK SHALL NOT PROGRESS UNTIL WRITTEN PERMISSION FROM THE ENGINEER IS OBTAINED.
- P. WHERE CONFLICTS OR DISCREPANCIES BETWEEN DRAWINGS AND SPECIFICATIONS EXIST THE CONTRACTOR SHALL NOTIFY THE ENGINEER IMMEDIATELY FOR CLARIFICATION. THE CONTRACTOR SHALL NOT ASSUME ANY ITEM TAKES PRECEDENCE OVER THE OTHER. ANY ACTION THE CONTRACTOR MAKES PRIOR TO NOTIFICATION SHALL BE AT THE CONTRACTOR'S RISK.
- Q. THESE DRAWINGS SHALL NOT BE SCALED TO OBTAIN DIMENSIONS. IF THE DIMENSIONS CANNOT BE DETERMINED BY THE INFORMATION GIVEN, CONTRACTOR SHALL CONTACT ENGINEER FOR REQUIRED INFORMATION.
- R. SITE OBSERVATION BY THE ENGINEER IS SOLELY FOR THE PURPOSE OF DETERMINING IF THE WORK OF THE CONTRACTOR IS PROCEEDING IN ACCORDANCE WITH THE STRUCTURAL CONTRACT DOCUMENTS. THIS LIMITED SITE OBSERVATION SHOULD NOT BE CONSTRUED AS EXHAUSTIVE OR CONTINUOUS TO CHECK THE QUALITY OR QUANTITY OF THE WORK, BUT RATHER PERIODIC IN AN EFFORT TO GUARD THE OWNER AGAINST DEFECTS OR DEFICIENCIES IN THE WORK OF THE CONTRACTOR.
- S. THE DRAWINGS, SPECIFICATIONS, AND OTHER DOCUMENTS PREPARED BY DLZ INDIANA, LLC (DLZ) FOR THIS PROJECT ARE INSTRUMENTS OF THE ENGINEER'S SERVICE, AND MAY BE USED SOLELY WITH RESPECT TO THE PROJECT AND, UNLESS OTHERWISE PROVIDED, THE ENGINEER SHALL BE DEEMED THE AUTHOR OF THESE PLANS AND RETAINS ALL COMMON LAW RIGHTS, TITLES AND INTEREST THEREIN. THE OWNER SHALL BE PERMITTED TO RETAIN COPIES, INCLUDING REPRODUCIBLE COPIES, OF THE ENGINEER'S DRAWINGS, SPECIFICATIONS OTHER DOCUMENTS FOR INFORMATION AND REFERENCE IN CONNECTION WITH THE OWNER'S USE AND OCCUPANCY OF THE PROJECT. DLZ SHALL NOT BE LIABLE FOR ANY HARM OR DAMAGE SUFFERED BY ANY PARTY BY REASON OF THE UNAUTHORIZED USE OF THESE PLANS. DLZ EXPRESSLY RESERVES ITS COPYRIGHTS IN THESE PLANS. THESE PLANS MAY NOT BE REPRODUCED, CHANGED, OR COPIED IN ANY FORM OR MANNER WHATSOEVER, NOR MAY THEY BE ASSIGNED OR OTHERWISE MADE AVAILABLE TO ANY THIRD PARTY WITHOUT FIRST OBTAINING THE EXPRESS WRITTEN
- T. THE CONTRACTOR IS SOLELY RESPONSIBLE FOR THE DESIGN, INSTALLATION, AND REMOVAL OF ALL TEMPORARY BRACING AND CONSTRUCTION SUPPORTS, FOR NEW AND EXISTING STRUCTURES, AS NECESSARY TO COMPLETE THE PROJECT. NO PORTION OF THE PROJECT, WHILE UNDER CONSTRUCTION, IS INTENDED TO BE STABLE IN THE ABSENCE OF THE CONTRACTOR'S TEMPORARY BRACES AND SUPPORTS UNTIL ALL OF THE STRUCTURAL ELEMENTS ARE IN PLACE AND FULLY CONNECTED AS INDICATED ON THESE DRAWINGS. CONTRACTOR SHALL RETAIN A LICENSED PROFESSIONAL ENGINEER TO DESIGN ALL TEMPORARY BRACING AND CONSTRUCTION SUPPORTS


#### 2. DESIGN DATA


- ALL DESIGN IS IN CONFORMANCE WITH THE 2014 INDIANA BUILDING CODE (2012 INTERNATIONAL BUILDING CODE AS AMENDED BY THE INDIANA ADMINISTRATIVE CODE) (IBC). RISK CATEGORY IS TYPE III.
- B. DESIGN DEAD LOADS: WEIGHT OF ALL MATERIALS OF CONSTRUCTION INCORPORATED INTO THE BUILDING
- 1) STAIRCASE 10 PSF
- 1) LOAD TYPE UNIFORM (PSF) **CONCENTRATED (POUNDS)**
- 2) FLOOR LIVE LOAD
- D. SNOW LOADING CRITERIA
- E MATERIALS:
- 1) CLAY BRICK (SOLID) ASTM C-62, GRADE SW
- 2) MORTAR ASTM C270 TYPE S 3) STRUCTURAL STEEL:
- A) PLATES, BARS, RODS, ANGLES AND CHANNELS A36, HOT DIP GALV. AFTER FABRICATION
- 4) FILLER METAL FOR WELDING: SHIELDED METAL ARC WELDING AWS A5.1 OR A5.5 OR E70XX
- F. DESIGN STANDARDS:
- 1) TMS 402-11 "BUILDING CODE REQUIREMENTS FOR MASONRY STRUCTURES" ASD 2) ANSI/AISC 360-10 "SPECIFICATION FOR STRUCTURAL STEEL BUILDINGS" - ASD


- A. MASONRY CONSTRUCTION SHALL CONFORM TO TMS602-11 "SPECIFICATION FOR MASONRY STRUCTURES AND COMMENTARY". CONTRACTOR
- SHALL MAINTAIN A COPY OF THIS REFERENCED SPECIFICATION ON SITE DURING CONSTRUCTION OF ALL MASONRY WALLS. B. ALL MASONRY JOINTS SHALL HAVE CONCAVE JOINTS AND BE FULLY BEDDED IN MORTAR.
- 4. SELECTIVE STRUCTURE DEMOLITION
- A. AREAS OF THE EXISTING CONSTRUCTION REQUIRE DEMOLITION AND REMOVAL OF SELECTED PORTIONS OF THE BUILDING OR STRUCTURE. B. PRE-DEMOLITION MEETINGS SHALL BE CONDUCTED TO DISCUSS CONDITION OF CONSTRUCTION TO BE SELECTIVELY DEMOLISHED, REVIEW STRUCTURAL LIMITATIONS, REVIEW AND FINALIZE SELECTIVE DEMOLITION SCHEDULE, DEMOLITION PERSONNEL, EQUIPMENT, AND OTHER REQUIREMENTS NECESSARY TO MAKE PROGRESS AND AVOID DELAYS, REVIEW REQUIREMENTS OF WORK PERFORMED BY OTHER TRADES THAT RELY ON THE SUBSTRATES EXPOSED BY SELECTIVE DEMOLITION OPERATIONS AND REVIEW AREAS WHERE EXISTING CONSTRUCTION IS
- TO REMAIN AND REQUIRES PROTECTION. C. NOTIFY ENGINEER/ARCHITECT OF DISCREPANCIES BETWEEN EXISTING CONDITIONS AND DRAWINGS BEFORE PROCEEDING WITH SELECTIVE
- D. PROVIDE AND MAINTAIN TEMPORARY SHORING, BRACING, AND STRUCTURAL SUPPORTS AS REQUIRED TO PRESERVE STABILITY AND PREVENT MOVEMENT, SETTLEMENT, OR COLLAPSE OF CONSTRUCTION AND FINISHES TO REMAIN, AND TO PREVENT UNEXPECTED OR UNCONTROLLED MOVEMENT OR COLLAPSE OF CONSTRUCTION BEING DEMOLISHED. STRENGTHEN OR ADD NEW SUPPORTS WHEN REQUIRED DURING PROGRESS OF SELECTIVE DEMOLITION. MEANS OF PROTECTION SHALL BE DESIGNED BY A QUALIFIED PROFESSIONAL ENGINEER LICENSED IN
- E. DEMOLISH TO THE EXTENTS INDICATED IN THE CONTRACT DOCUMENTS. CONTRACTOR TO REPAIR OR REPLACE UNAUTHORIZED DEMOLITION OR ANY ITEMS DAMAGED BY DEMOLITION ACTIVITIES AT NO ADDITIONAL COST TO THE OWNER.
- F. SUGGESTED SEQUENCE OF CONSTRUCTION:


THE STATE WHERE THE PROJECT IS TO BE BUILT.

- PROVIDE NEW TEMPORARY SUPPORT FROM THE SLAB-ON-GRADE OR PERMANENT SUPPORT OF RELOCATED UTILITIES FOR ALL EXISTING UTILITIES UNDER STONE STAIRS. 2) DEMO UTILITY SUPPORT ATTACHING UTILITIES.
- 3) DEMO EXISTING HANDRAIL.
- 4) REMOVE STONE STAIRS FROM CURRENT LOCATION. ANY DAMAGED STONE STAIRS MUST BE REPLACED. DEMO ALL STEEL SUPPORT ANGLES.
- DEMO ANY DETERIORATED BRICKS FROM BRICK WALLS UNDER STONE STAIRS RECONSTRUCT BRICK WALL AND REPOINT JOINTS TO FACILITATE NEW ANGLE OR STONE STAIR BEARING.
- 8) INSTALL NEW ANGLES IN INDICATED LOCATIONS.
- 9) RESET STONE STAIRS.
- 10) INSTALL NEW HANDRAILS IN PREVIOUS LOCATIONS 11) PROVIDE MORTAR AND JOINT SEALANT BETWEEN EACH STAIR.

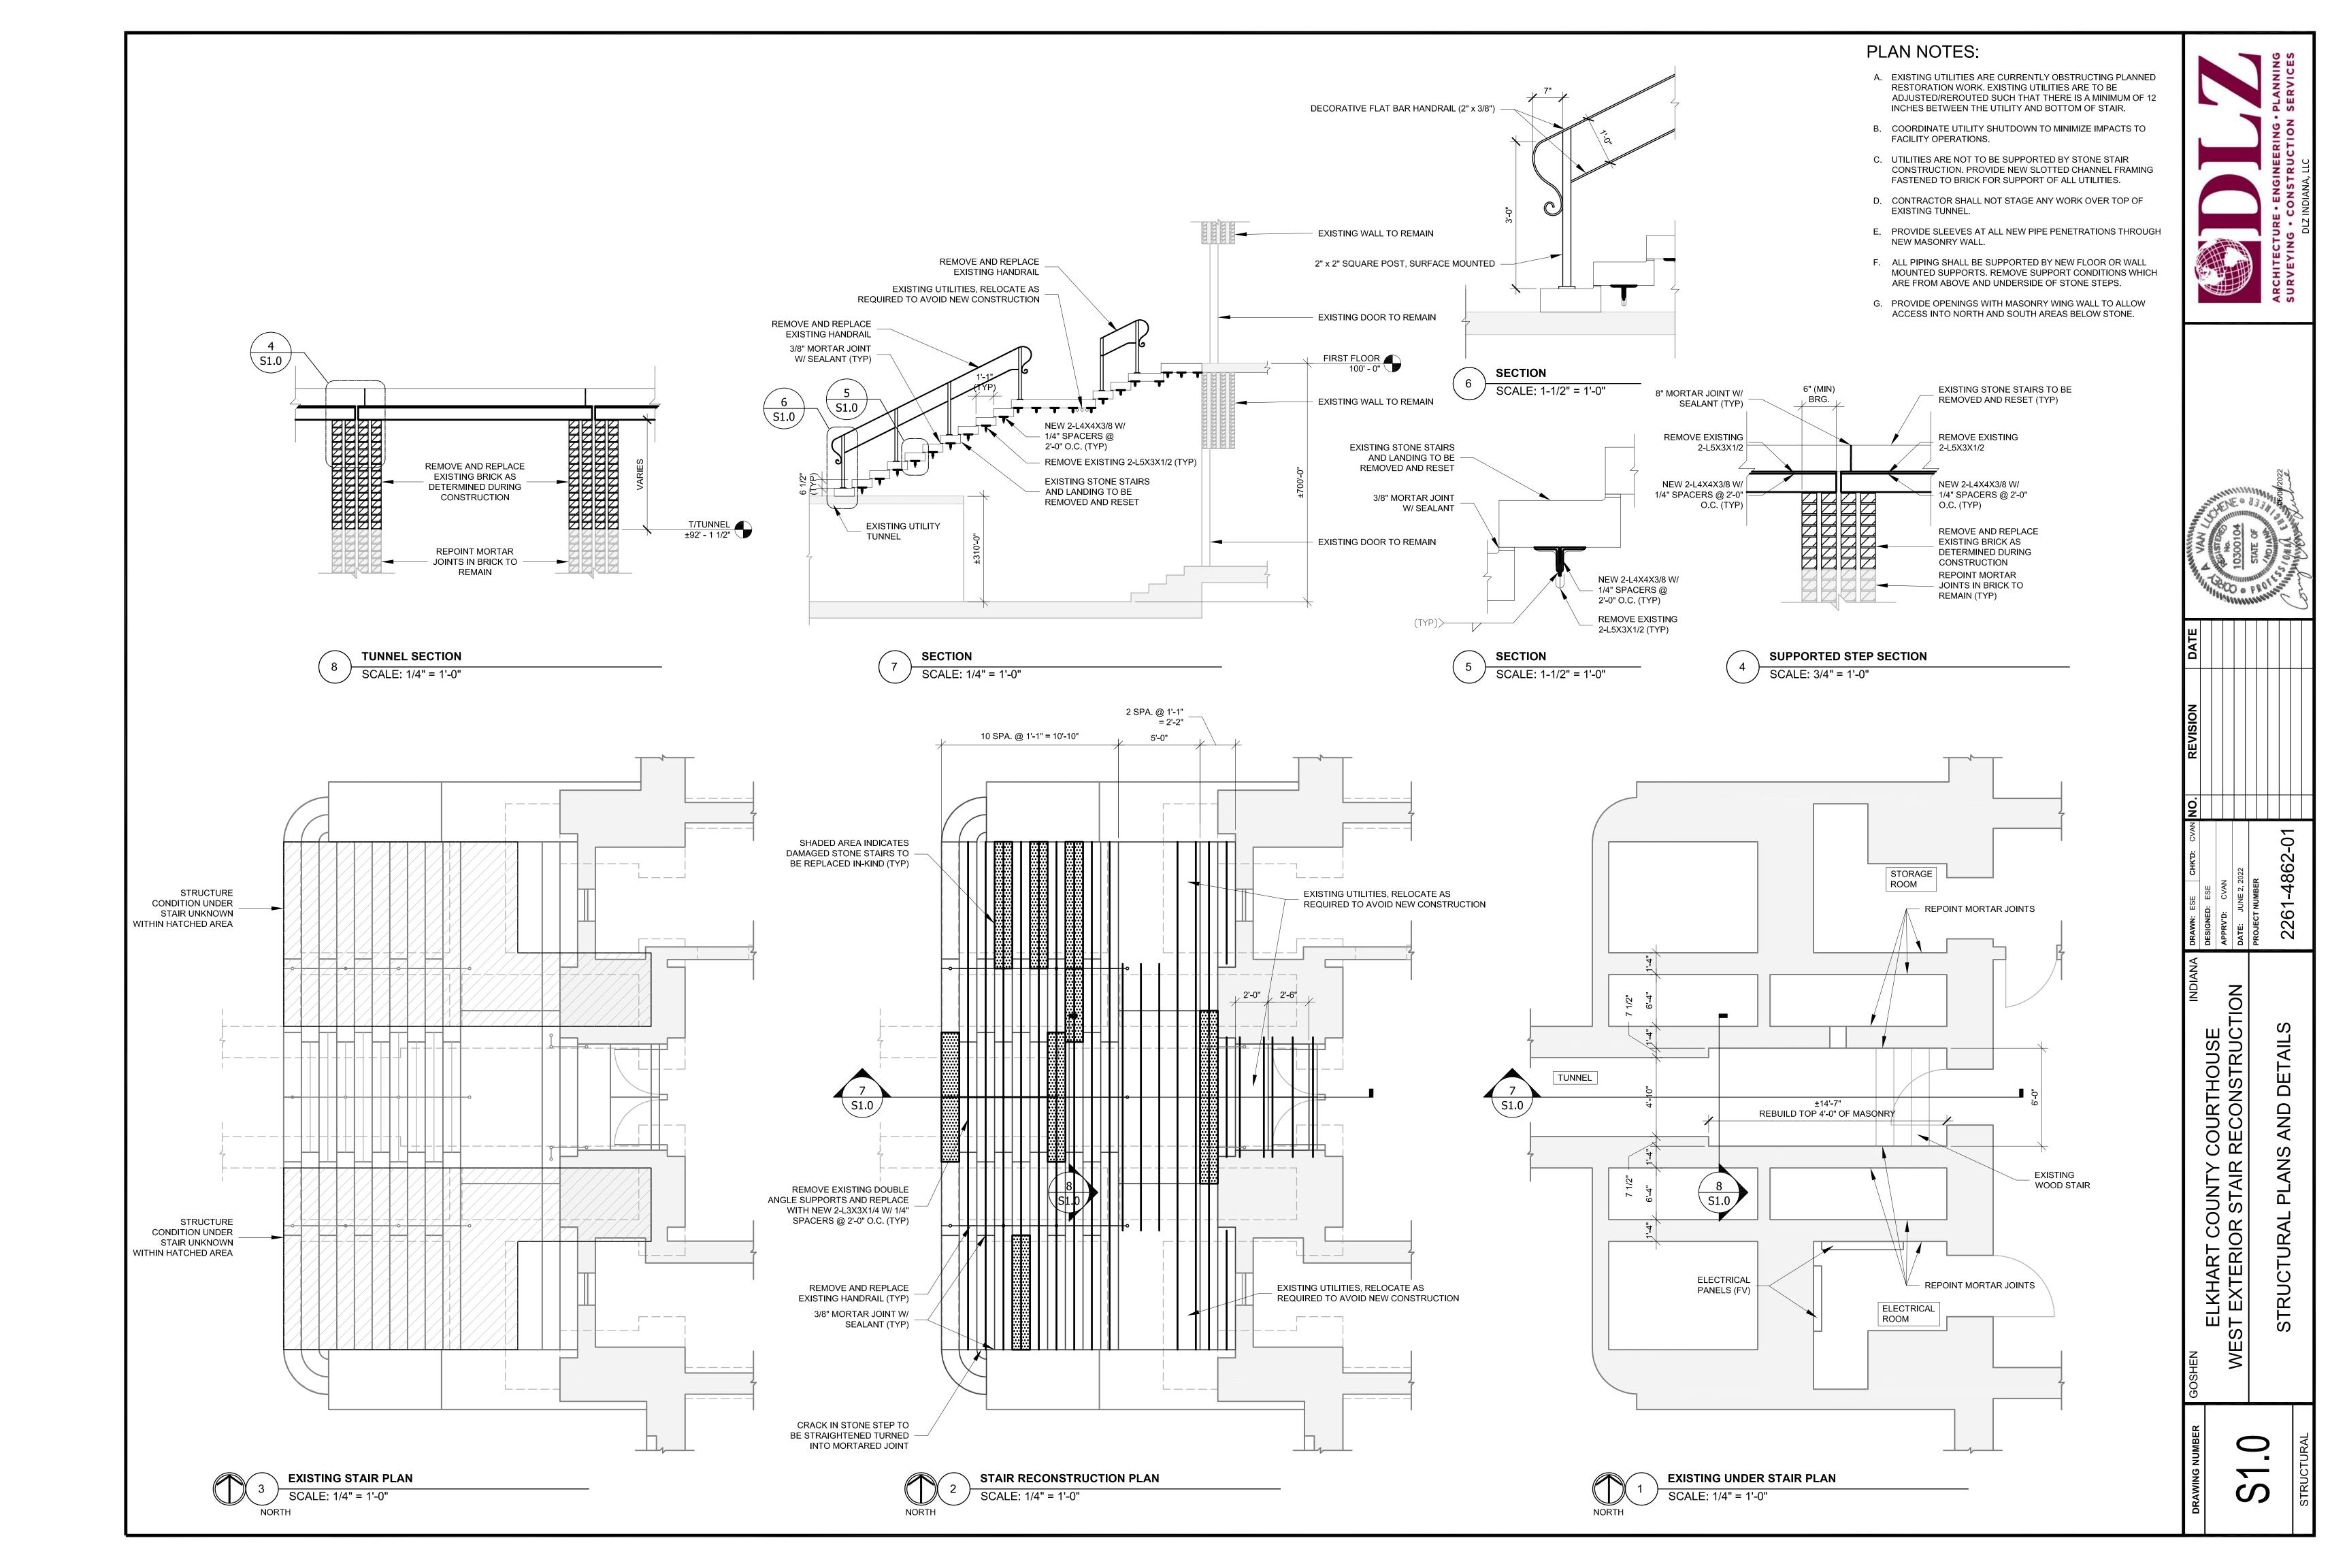

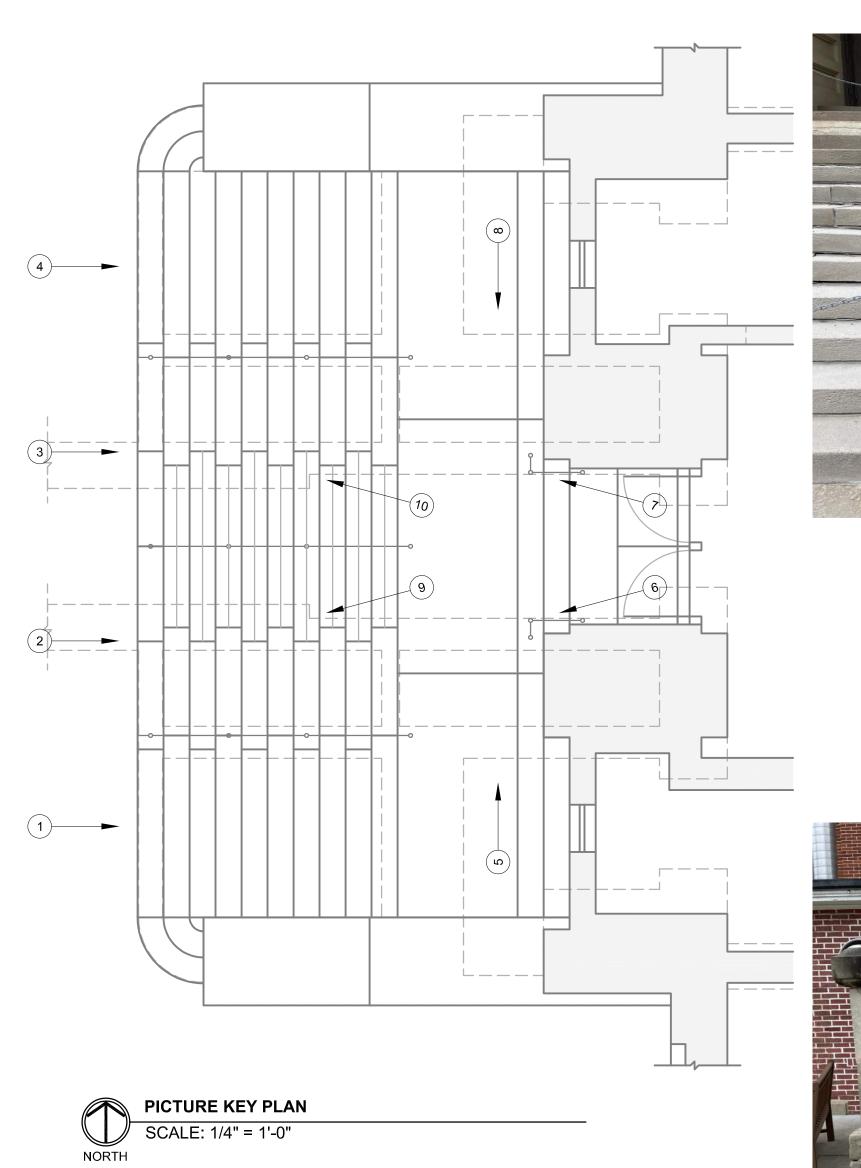

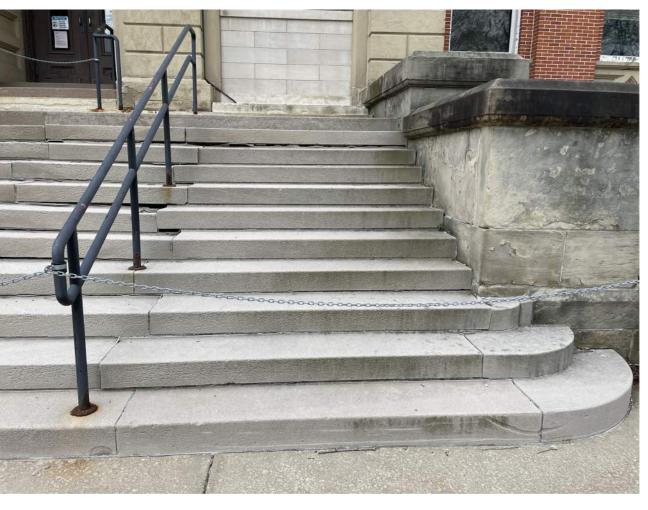

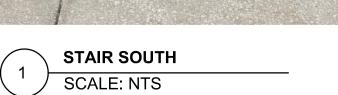





STAIR MIDDLE SOUTH SCALE: NTS




STAIR MIDDLE NORTH SCALE: NTS

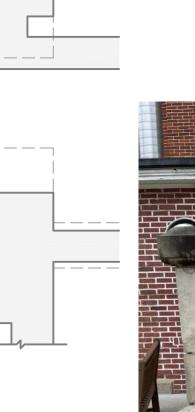


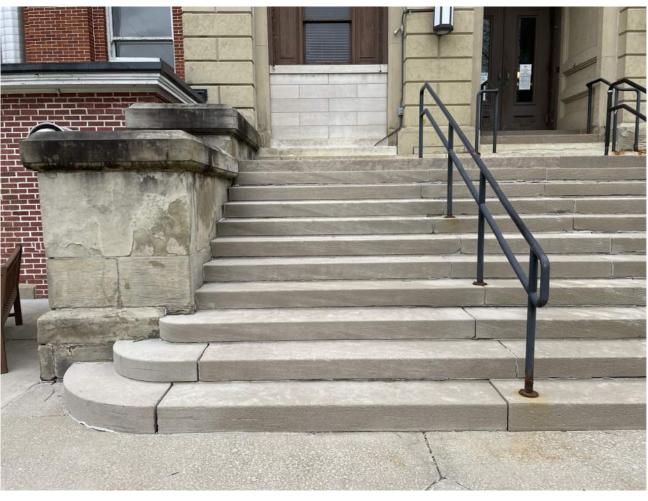


4 SCALE: NTS

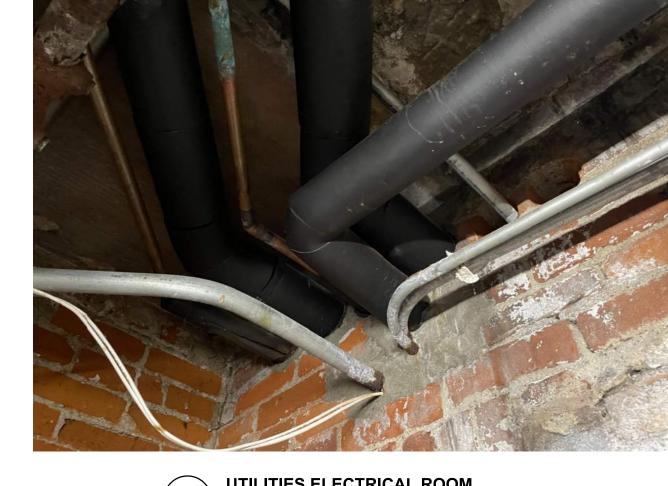




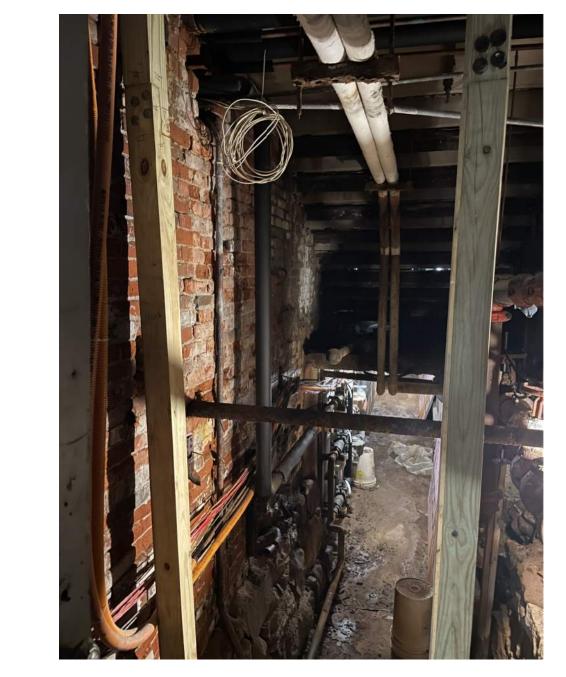


6 SCALE: NTS

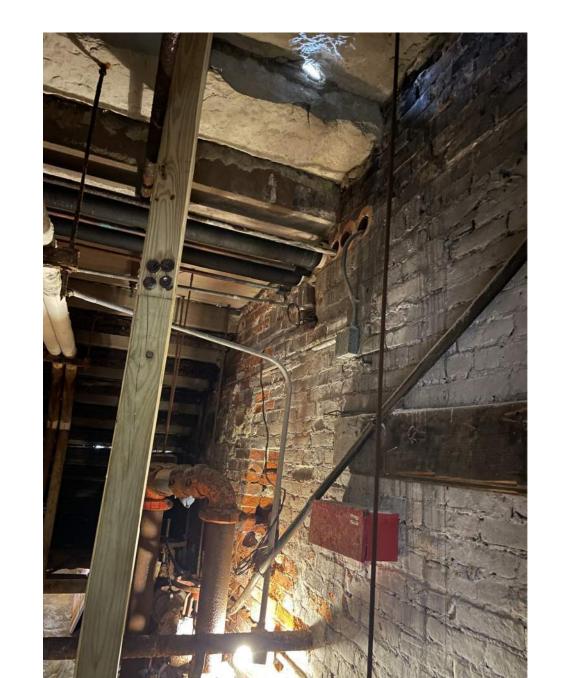




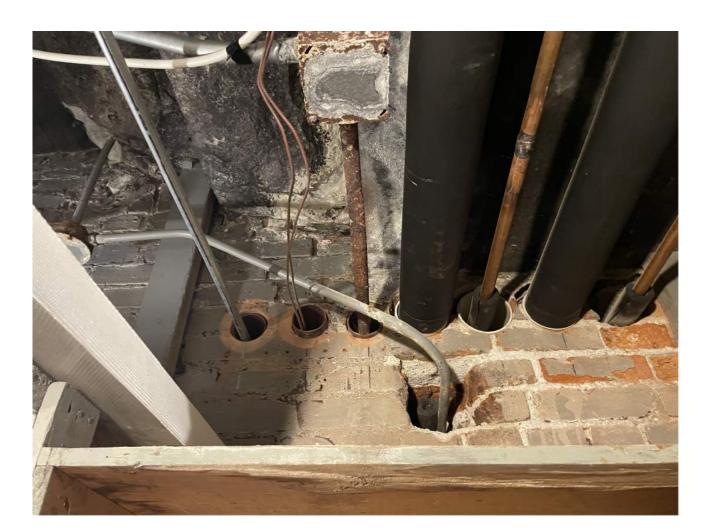

UTILITIES IN STORAGE ROOM SCALE: NTS

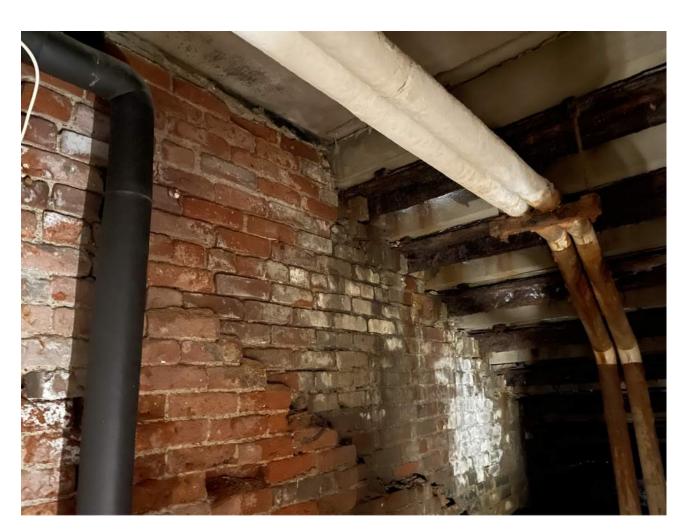

TUNNEL LOOKING SOUTH SCALE: NTS

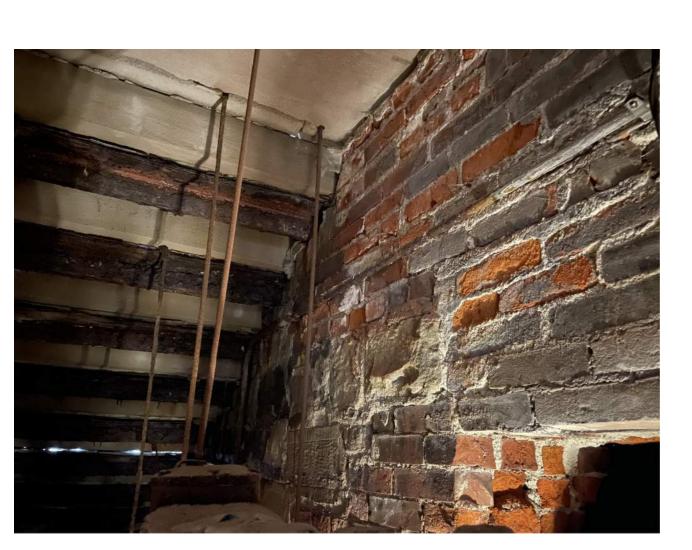

SCALE: NTS  $\left(10\right)$ 

S

ELKHART COUNTY COURTHOUSE ST EXTERIOR STAIR RECONSTRUC